


location plan 1:1000 @ A0





skateable infrastructure - 750 sq. metres  $_{1:250\ @\ A0}$ 

proposed surface level + 2.700

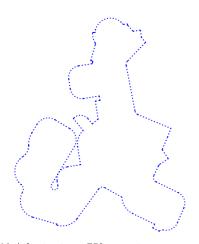





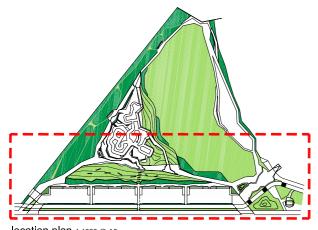

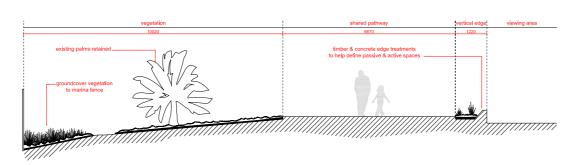

location plan 1:1000 @ A0 typical marina edge section 1:50 @ A0

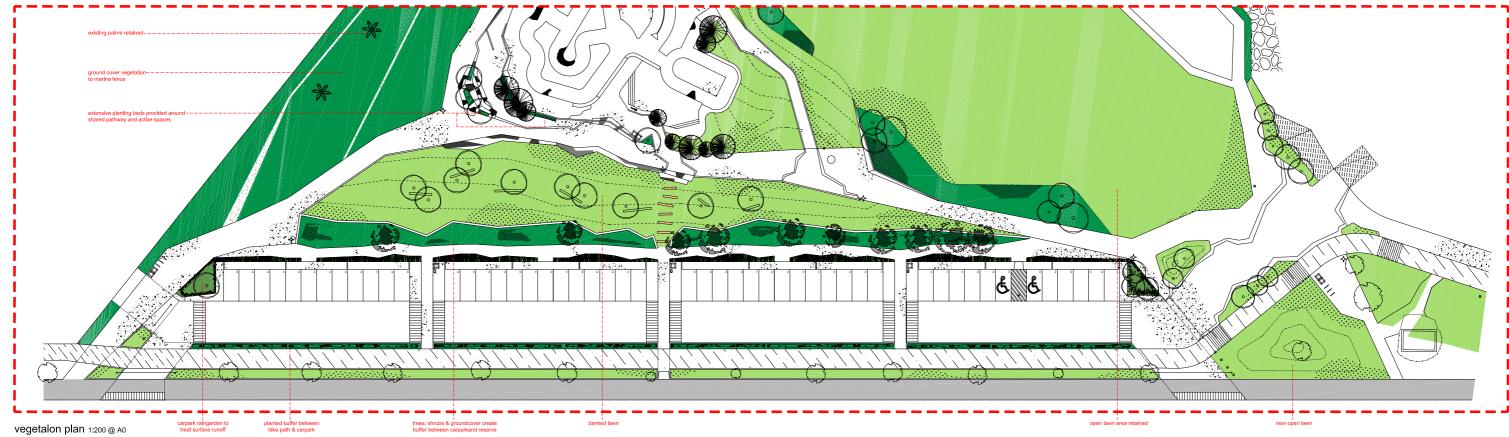

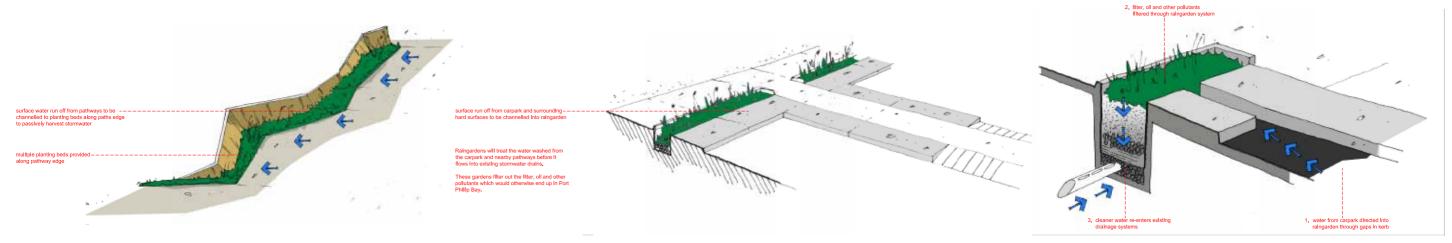










# marina reserve skateable infrastructure




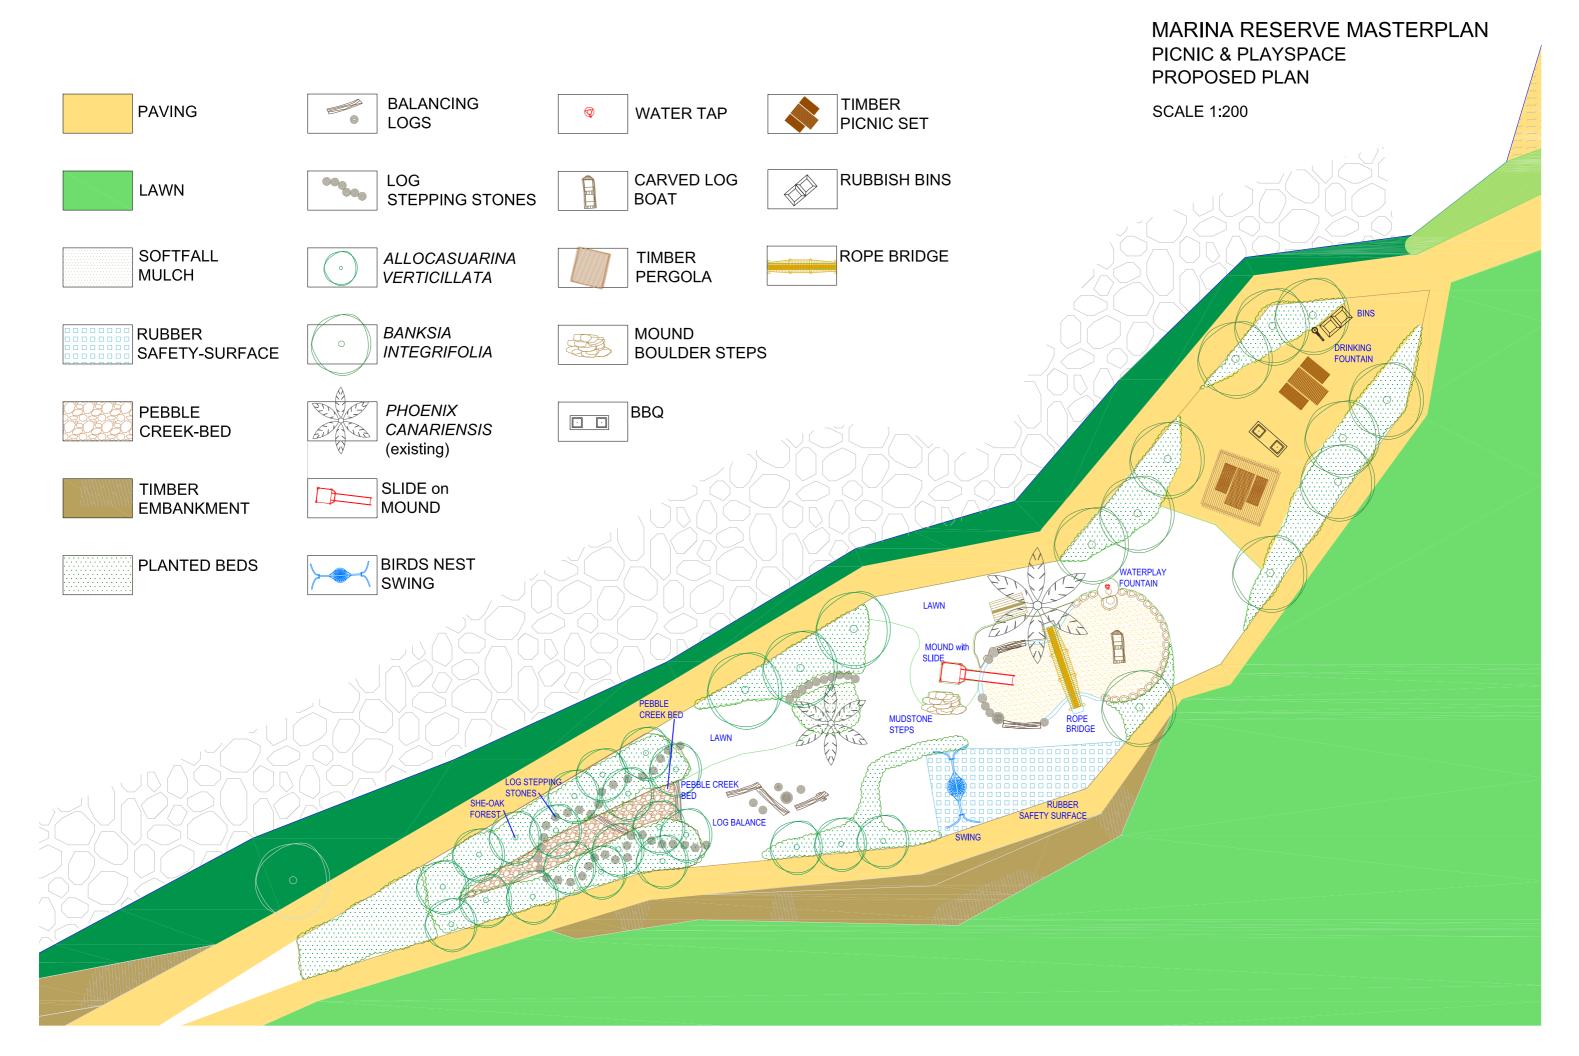


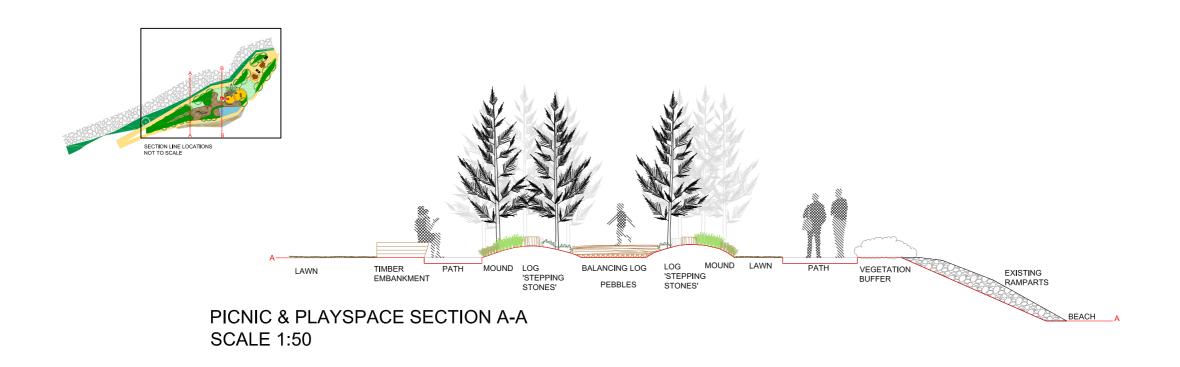

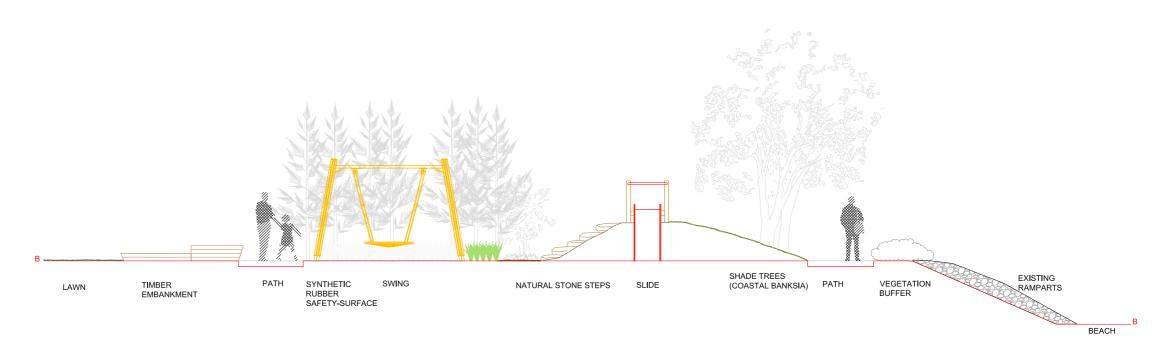

PICNIC & PLAYSPACE SECTION B-B SCALE 1:50

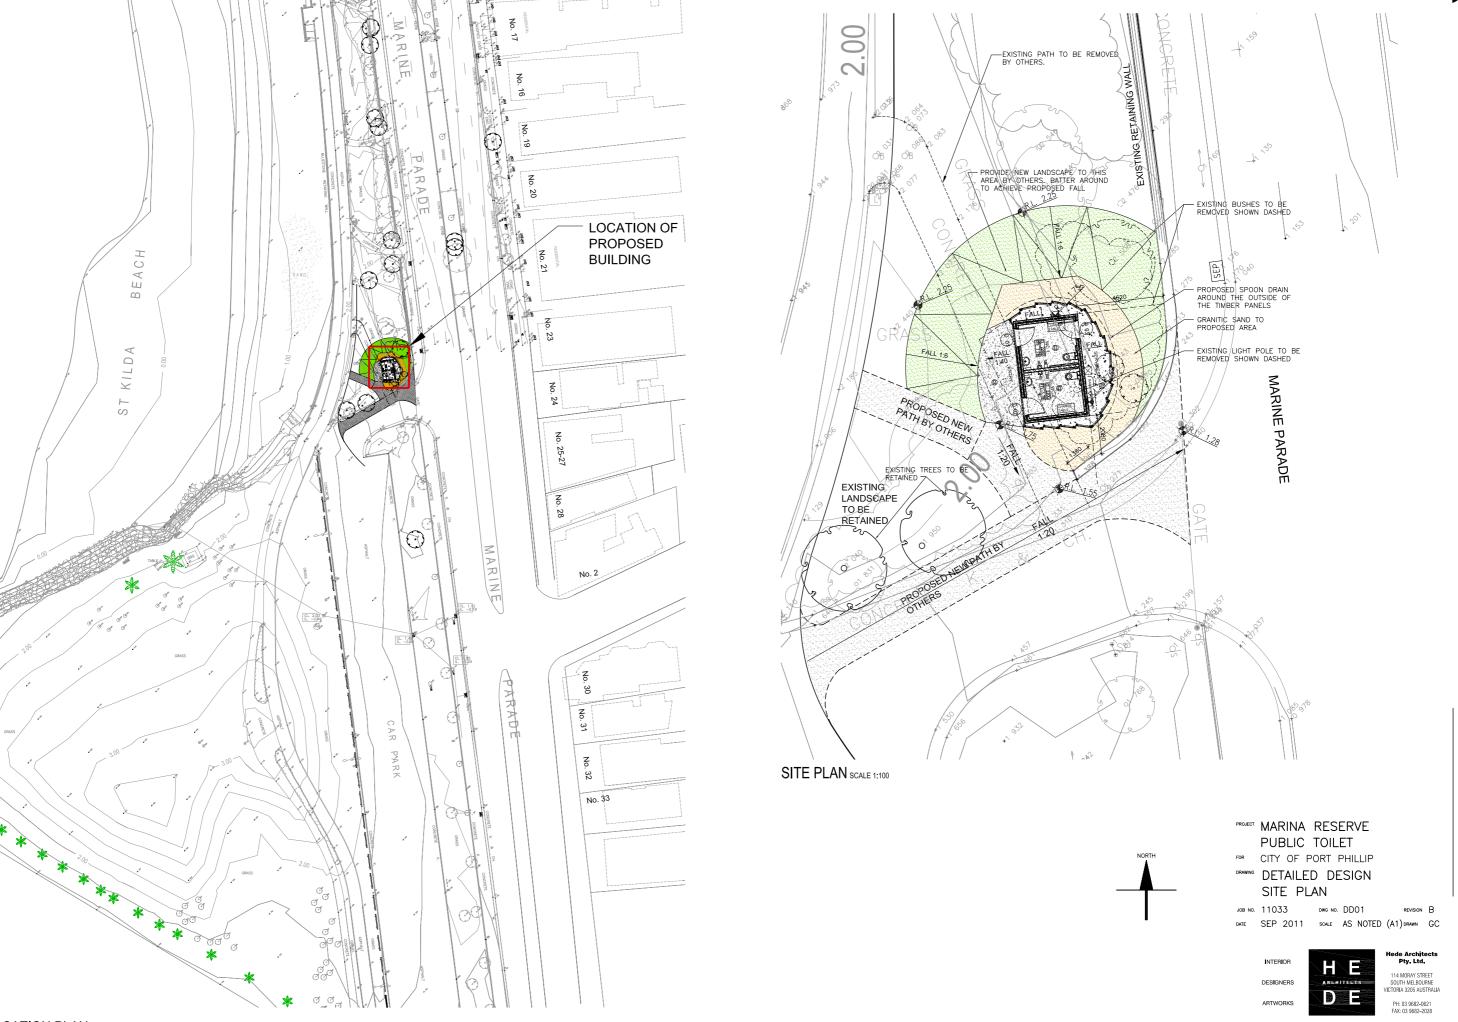

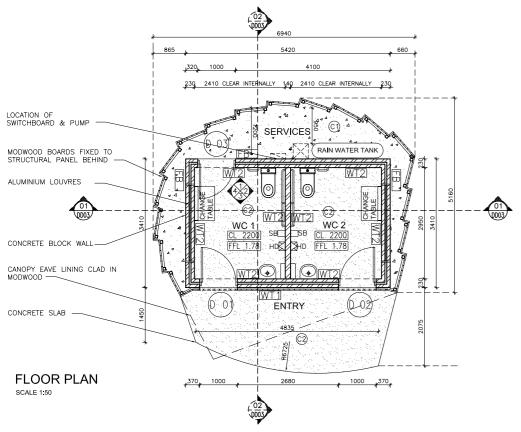

#### ROOF NOTE:

PROVIDE & PROPERLY FLASH ALL ROOF PENETRATIONS REQUIRED FOR SERVICES. NOT ALL ROOF PENETRATIONS ARE SHOWN ON ARCHITECTURAL DRAWINGS. REFER TO SERVICES DRAWINGS FOR DETAILS OF ALL SERVICES WHICH ARE REQUIRED TO PENETRATE ROOF

ALL LEVELS SHOWN ON ROOF PLAN ARE THE HEIGHT TO AHD

ENSURE ALL SOAKER FLASHINGS ARE WIDE ENOUGH TO ENSURE THE ROOF IS WATER TIGHT IN ALL RAIN CONDITIONS.

PROVIDE TRIMMERS AND PROPERLY SUPPORT CUT EDGES OF ROOF DECKING AT ALL PENETRATIONS SUPPLY AND INSTALL ROOF SAFETY ACCESS SYSTEM

COMPRISING OF LADDER HOOKS, ANCHOR POINTS AND STATIC WIRES TO EQUIPMENT & GUTTERS LOCATED ON ROOF EXTENDING FROM THE LADDER HOOK LOCATION SHOWN AND COMPLYING WITH AS/NZ 1891.4

#### **INSULATION NOTES:**

SUPPLY & INSTALL AIR-CELL GLARESHIELD SISILATION BELOW ALL METAL DECK ROOFING. IN ADDITION SUPPLY AND INSTALL 110 MM THICK BRADFORD GLASSWOOL GOLD BATTS ABOVE ALL CEILINGS.

THE ROOF IS TO ACHIEVE AN OVERALL R-VALUE RATING OF R3.3

#### **CEILING NOTE:**

ALL CEILING LEVELS ARE MEASURED AS THE HEIGHT ABOVE THE FINISHED FLOOR LEVEL.

NOTE THAT NOT ALL REQUIRED HATCHES ARE INDICATED ON THE ARCHITECTURAL DRAWINGS.

CEILING FRAME TO BE TRIMMED AS REQUIRED TO ACCOMMODATE RECESSED LIGHT FITTINGS & OTHER CEILING SERVICES SUPPLY & INSTALL 9 MM THICK VILLABOARD FLUSH SET LINING ON GYPROCK SCREW UP SUSPENDED CEILING SYSTEM COMPLETE WITH DOWN STRUTTING TO CEILING AND EAVES SOFFITS

### **GENERAL LEGEND**

COL COLUMN AS SCHEDULED ON STRUCTURAL

#### WALL TYPE LEGEND

ALL EXTERNAL WALLS SHALL BE DOUBLE CONCRETE BLOCK WALLS.

INTERNAL WALL SHALL BE SINGLE CONCRETE BLOCK WALL AS SPECIFIED TO BOTH SIDES.

FB FACE BLOCK AS SPECIFIED

WT1 MODWOOD MARINA BOARDS OVER PAINTED CONCRETE BLOCK WALL

WT2 ANTI-GRAFFITI COATING AS SPECIFIED OVER PAINTED CONCRETE BLOCK WALL

#### FLOOR FINISHES LEGEND

- (C1) CONCRETE SEALED NON-SLIP PLAIN FINISH
- CONCRETE BOARDWAY & FRAM PREMIX CONCRETE © EXPOSED CREATIONS "ECLYPSE LIMESTONE"
- S COLORED GRANITIC SAND

ENSURE THE SURFACES OF ALL ADJACENT FLOOR FINISHES ARE FINISHED LEVEL


#### **EXTERNAL FINISHES LEGEND**


- MODWOOD MARINA BOARD 137X32MM IN COLOR M1 AS SCHEDULED
- (M2) MODWOOD MARINA BOARD 137X32MM IN COLOR M2 AS SCHEDULED

# 9 MM THICK VILLABOARD LINING FLUSH SET LINING ON GYPROCK SCREW UP SUSPENDED SYSTEM COMPLETE WITH DOWN STRUTTING TO EAVES SOFFITS **SERVICES** FALL 5° 9 MM THICK VILLABOARD FLUSH SET LINING ON GYPROCK SCREW UP SUSPENDED CEILING SYSTEM COMPLETE WITH DOWN STRUTTING RAIN WATER TANK WT2 WC 2 WC


#### REFLECTED CEILING PLAN

SCALE 1:50

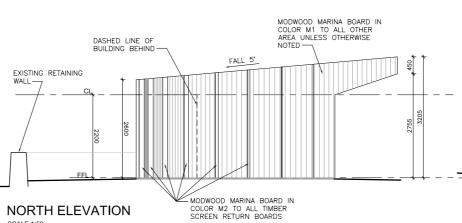

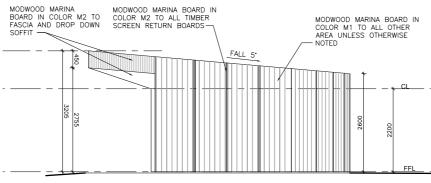



## SOUTH ELEVATION

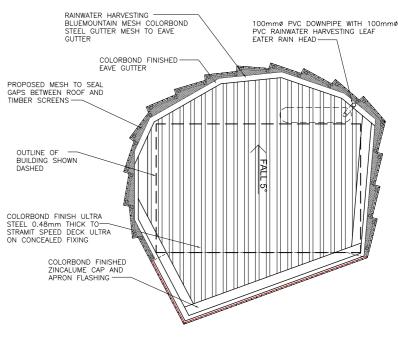

#### **ROOF PLAN**

SCALE 1:50

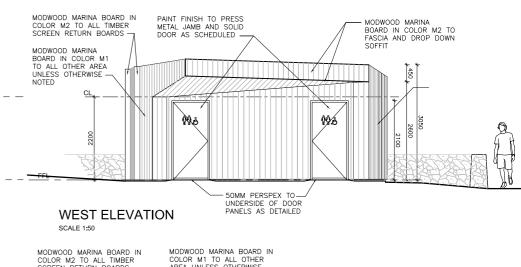

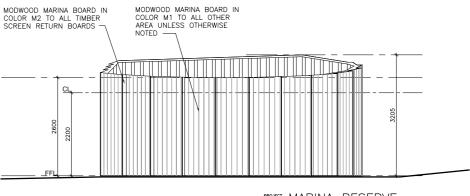

#### EAST ELEVATION

SCALE 1:50




PLANS & ELEVATIONS JOB NO. 1103.3


DWG NO. DDO2 DATE SEPT '11 SCALE 1:50 (A1) DRAWN GC


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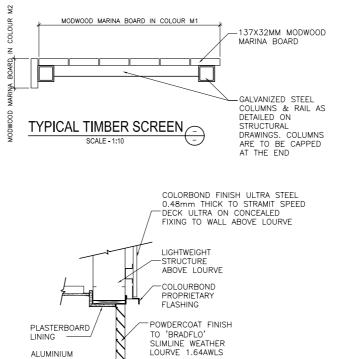
Pty. Ltd. 47 STOKES STREET PORT MELBOURNE VICTORIA 3207 AUSTRALIA PH: 03 9646-7460

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CONCRETE

SECTIONAL DETAIL 3

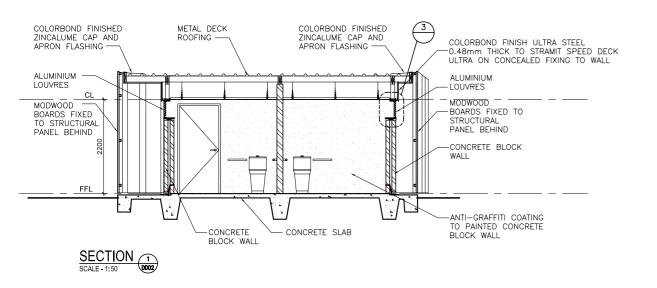BLOCK WALL

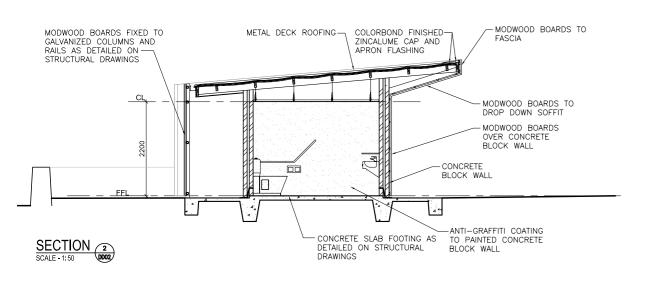SILL

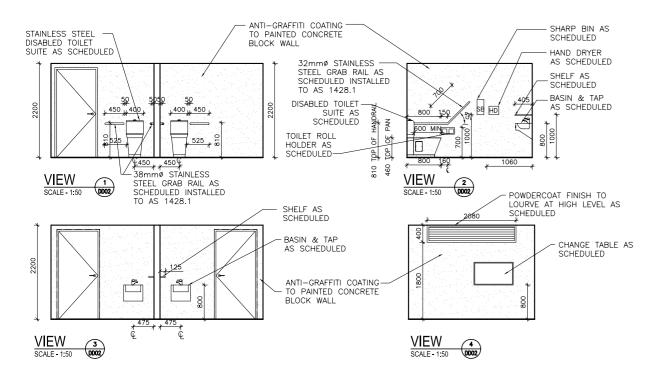PROJECT MARINA RESERVE

PUBLIC TOILET

FOR CITY OF PORT PHILLIP

DRAWING DETAILED DESIGN

DETAILED DESIGN
SECTIONS & DETAILS

JOB NO. 11033 DWG NO. DD03

DATE SEPT '11 SCALE 1:50 (A1)

INTERIOR DESIGNERS



#### Hede Architects Pty. Ltd.

PORT MELBOURNE CTORIA 3207 AUSTRALIA PH: 03 9646-7460 FAX: 03 9646-1933

DRAWN GC





